
65 Bullecourt Ave, Milperra

Granny Flat

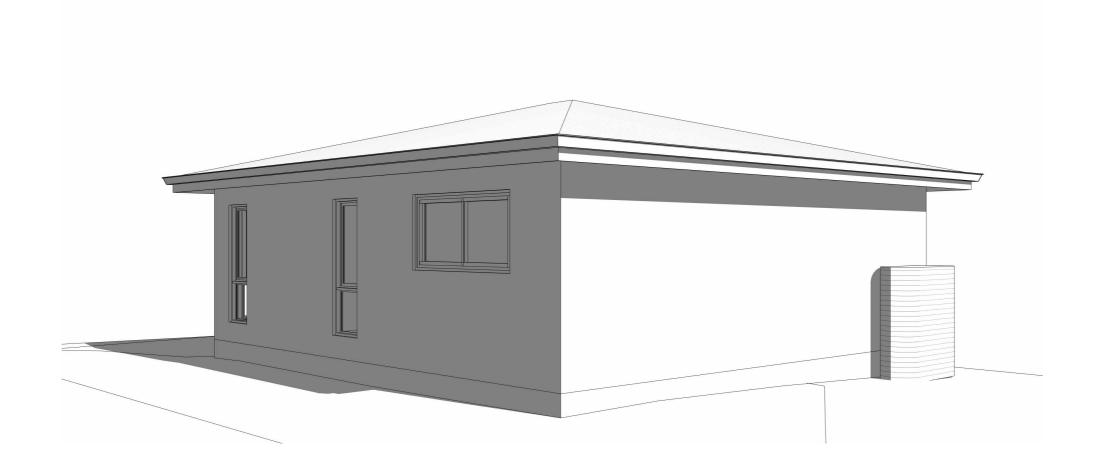



LESIGN & CONSTRUCT

CONCEPT TO REALITY

DEVELOPMENT DATA

LOT SIZE: 575.4m ²			
COUNCIL COMPLIANCE	ALLOWED	PROVIDED	COMPLY
MIN FRONTAGE	15m	15.54m	YES
MAX SITE COVERAGE	N/A	N/A	YES
FLOOR SPACE RATIO	0.5:1 - 60m² (Granny Flat)	0.25:1	YES
MAX BUILDING HEIGHT	4.5m	3.8m	YES
FRONT SETBACK	4.5m	28m	YES
SIDE SETBACK 1	0.9m	3.6m	YES
SIDE SETBACK 2	0.9m	3.9m	YES
REAR SETBACK	0.9m	0.9m	YES
CORNER SETBACK	N/A	N/A	N/A
LANDSCAPE AREA	min 45% of front frontage	55.48%	YES
PRIVATE OPEN SPACE	80m²	80.6m ²	YES
SITE CALCULATION			
EXISTING DWELLING	87m²		
PROPOSED GARAGE	N/A		
PROPOSED GRANNY FLAT	60m²		

AERIAL MAP

SITE ANALYSIS PLAN GURBANEINTY 65 Bullecourt Ave Milperra, 2214 NSW MGA Zone EPSG 28356 313578.9, 6242980.6 313658.9, 6243060.6 Site Address: CRS: Extent: Nearmap Imagery: Latitude: Longitude: Resolution: -33.93679° 150.98340° 0.050 m 2023-11-19 Capture Date:





LOCATION MAP

Site Address:	65 Bullecourt Ave
	Milperra, 2214 NSW
CRS:	MGA Zone EPSG 28356
Extent:	313578.9, 6242980.6 313658.9, 6243060.6
	313058.9, 6243060.0
Cadastre:	
Latitude:	-33.93679°
Longitude:	150.98340°
Cadastral Title:	3//DP235638
Cadastral Area:	568.57 som
Orientation:	True Narth
Tile Size:	80m x 80m
Scale:	8.0 m
Stale.	N
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w	E
No.	

Sheet Schedule

00	Cover Page
0.1	Title Page
0.2	Basix Comments
0.3	Shadow Diagrams
01.0	Site Plan
01.1	Site Analysis
02.0	Ground Floor Plan
03.0	Elevations & Sections

- 04.0 Concept Landscape Plan
- Schedules 05.0
- 06.0 Neighbour Notification

NOTE: * Architectural documents are to be read in conjunction with relevant structural, fire service, mechanical, hydraulic, electrical, civil and landscaping documents. * Do not scale drawings. Use figured dimensions on nolk, inform Architect of any conflict between site conditions and documents. Contractor to verify all dimensions on site efore commencing work. * Any extra work entalled hereafter must be calimed and approval tobained befor proceeding otherwise no extra will allowed for. * All materials, appliances, fittings and finishes are to be installed in accordance with the manufacturer's recommendations and in compliance with the relevant Codes & Standards * These drawings are not to be used for construction unless drawings are stamp endorsed by Building	
Surveyor. * These documents may only be used for the purposed for which was commissioned and in accordance with the Terms of Engagement.	S





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Reg #: 2125/16



BASIX[°]Certificate

Single Dwelling Certificate number: 1779698S

erindete number. 17730300	
his certificate confirms that the proposed development will meet the NS	
overnment's requirements for sustainability, if it is built in accordance v	vith th
ommitments set out below. Terms used in this certificate, or in the com	mitm

government's requirements for sustainability, if it is built in accordance with the	
commitments set out below. Terms used in this certificate, or in the commitments,	
have the meaning given by the document entitled "BASIX Definitions" dated	
10/09/2020 published by the Department. This document is available at	
www.basix.nsw.gov.au	

Secretary Date of issue: Monday, 13 January 2025 To be valid, this certificate must be submitted with a development application or lodged w complying development certificate application within 3 months of the date of issue.



	Project name	C2402 - 65 Bullecourt Ave, Milperra	
	Street address	65 BULLECOURT Avenue MILPERF	RA 2214
	Local Government Area	Canterbury-Bankstown Council	
	Plan type and plan number	Deposited Plan DP235638	
	Lot no.	3	
	Section no.	-	
	Project type	dwelling house (detached) - seconda	ry dwelling
S ,	No. of bedrooms	2	
	Project score		
	Water	✓ 45	Target 40
	Thermal Performance	V Pass	Target Pass
vith a	Energy	✓ 71	Target 68
	Materials	✓ 38	Target n/a

Name / Company Name: CEDAR DESIGN & CONSTRUCT PTY LTD ABN (if applicable): 87616143661 US_03_01_0 Certificate No.: 1779698S Monday, 13 January 2025

page 1/11

Monday, 13 January 2025

page 5/11

BASIX Department of Infrastructure

BASIX Department of Planning, Housing and Infrastructure

RASIX

Department of Infrastructure

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Project summary

Certificate Prepared by

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Project address		Assessor details and then	rmal loads	
Project name	C2402 - 65 Bullecourt Ave, Milperra	Assessor number	n/a	
Street address	65 BULLECOURT Avenue MILPERRA 2214	Certificate number	n/a	
Local Government Area	Canterbury-Bankstown Council	Climate zone	n/a	
Plan type and plan number	Deposited Plan DP235638	Area adjusted cooling load (MJ/ m ² .vear)	n/a	
Lot no.	3			
Section no.	-	Area adjusted heating load (MJ/ m ² .year)	n/a	
Project type		Project score		
Project type	dwelling house (detached) - secondary dwelling	Water	¥ 45	Target 40
No. of bedrooms	2	1100	V 40	Target 40
Site details		Thermal Performance	V Pass	Target Pa
Site area (m²)	575	Energy		
Roof area (m²)	75	Lingy	✓ 71	Target 68
Conditioned floor area (m ²)	55.0	Materials	✓ 38	Target n/a
Unconditioned floor area (m ²)	5.0	L		÷
Total area of garden and lawn (m ²)	0			
Roof area of the existing dwelling (m ²)	135			
Number of bedrooms in the existing dwelling	3			

Schedule of BASIX commitments

Thermal Performance and Materials


BASIX

Department o

page 6/1

page 10/11

The commitments set out below regulate how the proposed development is to be carried out. It is a condition of any development consent granted, or complying development certificate issued, for the proposed development, that BASIX commitments be complied with.

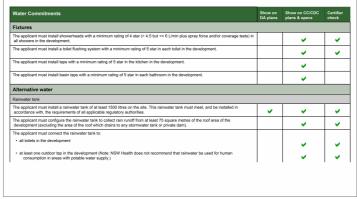

Department of P Infrastructure Monday, 13 January 2025 page 3/1

Show on Show on CC/CDC Certifier

Construction	Area - m²	Additional insulation required	Options to address thermal bridging	Other specifications
ceiling and roof - flat ceiling / pitched roof, framed - metal roof, timber - H2 treated softwood.	75	ceiling: 5 (up), roof: foil/ sarking ;ceiling: fibreglass batts or roll; roof: foil/sarking.	nil	roof space ventilation: wind- driven ventilator(s) + eave vents; roof colour: medium (solar absorptance 0.48-0.59); ceiling area fully insulated
Note Insulation specified in this	Cartificate must be installed in accord	dance with the ABCB Housing Provisio	ine (Part 12.2.2) of the National Conet	Inuction Code
		sater than R3.0, refer to the ABCB Hou		
		consideration of condensation and ass		
		plicable roofs in accordance with the A		•

www.basix.nsw.gov.au Version: 4.03 / EUCALYPTUS_03_01_0 Certificate No.: 1779698S

Thermal Performance and Materials commitments	Show on DA plans	Show on CC/CDC plans & specs	Certifier check
Ceiling fans			
The applicant must install at least one ceiling fan in at least one daytime habitable space, such as living room.	~	~	~
The applicant must install at least one ceiling fan in each bedroom.	~	~	~
The minimum number and diameter of ceiling fans in a daytime habitable space must be installed in accordance with the ABCB Housing Provisions (Part 13.5.2) of the National Construction Code.	~	~	~

Certificate No - 1779698S

Monday, 13 January 2025

page 2/1

						plans & specs	chec
Glazed windows, doors and	skylights						
The applicant must install the windows, glazed doors and shading devices described in the table below, in accordance with the specifications listed in the table. Relevant overshadowing specifications must be satisfied for each glazed window and door.					~	 	
The dwelling may have 1 skylight (<0.7 square metres) which is not listed in the table.					~	~	
The following requirements	must also be satisfied in relation	to each window and glazed do	bor:		~	~	
 The applicant must install table. 	windows and glazed doors in a	cordance with the height and v	vidth, frame and glazing types list	ed in the	~	~	
			lar Heat Gain Coefficient (SHGC) ional Fenestration Rating Council			~	•
 Vertical external louvres a closed. 	nd blinds must fully shade the g	lazed window or door beside w	hich they are situated when fully	drawn or	~	~	•
 Overshadowing buildingsi as specified in the 'oversha 		and distance from the centre a	and the base of the window and g	lazed door,	~	~	•
skylight area must not exce		e metre limit does not include t	e specifications listed in the table. the optional additional skylight of		~	~	•
Glazed window/door no.	Maximum height (mm)	Maximum width (mm)	Frame and glass specification	Shading (Dimensi	device on within 10	Overshadov %)	wing
North facing						_	
900.00 1800.00 aluminum, double glazed (U-value <= 2.0, SHGC: 0.22 < 0.27) external louvre/vertical bin (adjustable)					blind 1-2 m high, ·	d 1-2 m high, <1.5 m awa	
W02	600.00	900.00	aluminium, double glazed (U-value: <=2.0, SHGC: 0.22 - 0.27)	external la (adjustab	ouvre/vertical xle)	blind 1-2 m high, ·	<1.5 m aw

Energy Commitments	Show on DA plans	Show on CC/CDC plans & specs	Certifier check
lot water			
The applicant must install the following hot water system in the development, or a system with a higher energy rating: electric heat pump with a performance of 36 to 40 STCs or better.	~	~	~
Cooling system			
The living areas must not incorporate any cooling system, or any ducting which is designed to accommodate a cooling system.		~	~
The bedrooms must not incorporate any cooling system, or any ducting which is designed to accommodate a cooling system.		~	~
Heating system			
The living areas must not incorporate any heating system, or any ducting which is designed to accommodate a heating system.		~	~
The bedrooms must not incorporate any heating system, or any ducting which is designed to accommodate a heating system.		~	~
Ventilation		•	
The applicant must install the following exhaust systems in the development:			
At least 1 Bathroom: individual fan, open to façade; Operation control: manual switch on/off		~	v
Kitchen: individual fan, open to façade; Operation control: manual switch on/off		~	v
Laundry: individual fan, open to façade; Operation control: manual switch on/off		~	v
Artificial lighting			
The applicant must ensure that a minimum of 80% of light fixtures are fitted with fluorescent, compact fluorescent, or light-emitting- diode (LED) lamps.		~	~
Natural lighting			
The applicant must install a window and/or skylight in the kitchen of the dwelling for natural lighting.			

Energy Commitments	Show on DA plans	Show on CC/CDC plans & specs	Certifier check
The applicant must install a window and/or skylight in 1 bathroom(s)/toilet(s) in the development for natural lighting.	•	~	•
Other			
The applicant must install a fixed outdoor clothes drying line as part of the development.		~	
	-		

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Legend	
In these commitments, "applicant" r	means the person carrying out the development.
	n the "Show on DA plans" column must be shown on the plans accompanying the development application for the proposed development (if a dged for the proposed development).
Commitments identified with a V in certificate / complying development	n the "Show on CCICDC plans and specs" column must be shown in the plans and specifications accompanying the application for a construction t certificate for the proposed development.
Commitments identified with a V is final) for the development may be is	n the "Certifier check" column must be certified by a certifying authority as having been fulfilled, before a final occupation certificate (either interim o ssued.

NOTE: * Architectural documents are to be read in conjunction with relevant structural, fire service, mechanical, hydraulic, electrical, civil and landscaping documents. * Do not scale drawings. Use figured dimensions only. Inform Architect of any conflict between site conditions and documents. Contractor to verify all dimensions on site fore commencing work. *Any extra work entailed hereafter must be claimed and approval obtained befor proceeding otherwise no extra will adveced for. *All materials, appliances, fittings and finishes are to be installed in accordance with the manufacturer's recommendations and in compliance with the relevant Codes & Standards * These drawings are not to be used for construction unless drawings are stamp endorsed by Building Surveyor. * These documents may only be used for the purposed for which was commissioned and in accordance with the Terms of Engagement.

BASIX Department of Infrastructure

Thermal Performance and M	Show on DA plans	Show on CC/CDC plans & specs	Certifier check						
Do-it-yourself Method									
General features									
The dwelling must be a Class 1 dwe	~	~	~						
The conditioned floor area of the dw	elling must not exceed 300 squa	ire metres.		~	~	~			
The dwelling must not contain open	~	×	~						
The dwelling must not contain third I	~	×	~						
Floor, walls and ceiling/roof									
The applicant must construct the flor below.	~	~	~						
The applicant must adopt one of the ceiling/roof of the dwelling.	options listed in the tables below	w to address thermal bridging in metal fram	ed floor(s), walls and	~	~	~			
The applicant must show through re the tables below.	ceipts that the materials purchas	ed for construction are consistent with the	specifications listed in			~			
Construction		Additional insulation required	Options to address t bridging	hermal	Other specifications				
floor - suspended floor above enclosed subfloor, concrete - suspended; frame: no frame.	xclosed subfloor, concrete -								
external wall: framed (fibre cement sheet or boards); frame: timber - H2 treated softwood.	sheet or boards); frame: timber - construction);fibreglass batts or absorptance < 0.48)								
internal wall: plasterboard; frame: 37 none nil									

BASIX Department of Infrastructure FLICAL YPTUS 03 01 0 Certificate No : 17796985


Glazed window/door no.	Maximum height (mm)	Maximum width (mm)	Frame and glass specification	Shading device (Dimension within 10%)	Overshadowing
W03	900.00	1200.00	aluminium, double glazed (U-value: <=2.0, SHGC: 0.22 - 0.27)	external louvre/vertical blind (adjustable)	1-2 m high, <1.5 m away
South facing	•	·	•		•
WD4	1800.00	600.00	aluminium, double glazed (U-value: <=2.0, SHGC: 0.22 - 0.27)	external louvre/vertical blind (adjustable)	2-4 m high, 2-5 m away
W05	1800.00	600.00	aluminium, double glazed (U-value: <=2.0, SHGC: 0.22 - 0.27)	external louvre/vertical blind (adjustable)	2-4 m high, 2-5 m away
W06	900.00	1800.00	aluminium, double glazed (U-value: <=2.0, SHGC: 0.22 - 0.27)	external louvre/vertical blind (adjustable)	2-4 m high, 2-5 m away
West facing	•	•			
W07	1800.00	600.00	aluminium, double glazed (U-value: <=2.0, SHGC: 0.49 - 0.60)	external louvre/vertical blind (adjustable)	2-4 m high, 2-5 m away
W08	1800.00	600.00	aluminium, double glazed (U-value: <=2.0, SHGC: 0.49 - 0.60)	external louvre/vertical blind (adjustable)	2-4 m high, 2-5 m away




10 Emery Ave, Yagoona, NSW, 2199 www.cedardesign.com.au info@cedardesign.com.au A.B.N: 87 616 143 661 Phone: 0422 704 479 bda

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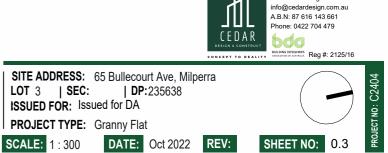
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gs. Use figured dimensions only. Inform Architect of any conflict rents. Contractor to verify all dimensions on site efore commence s, fittings and finishes are to be installed in a ince with the manufacture e with the relevant Codes & Standards d for construction unless drawings are stamp endorsed by Building oned and ir


ents may only be used for the purposed for which was co the Terms of Engagement
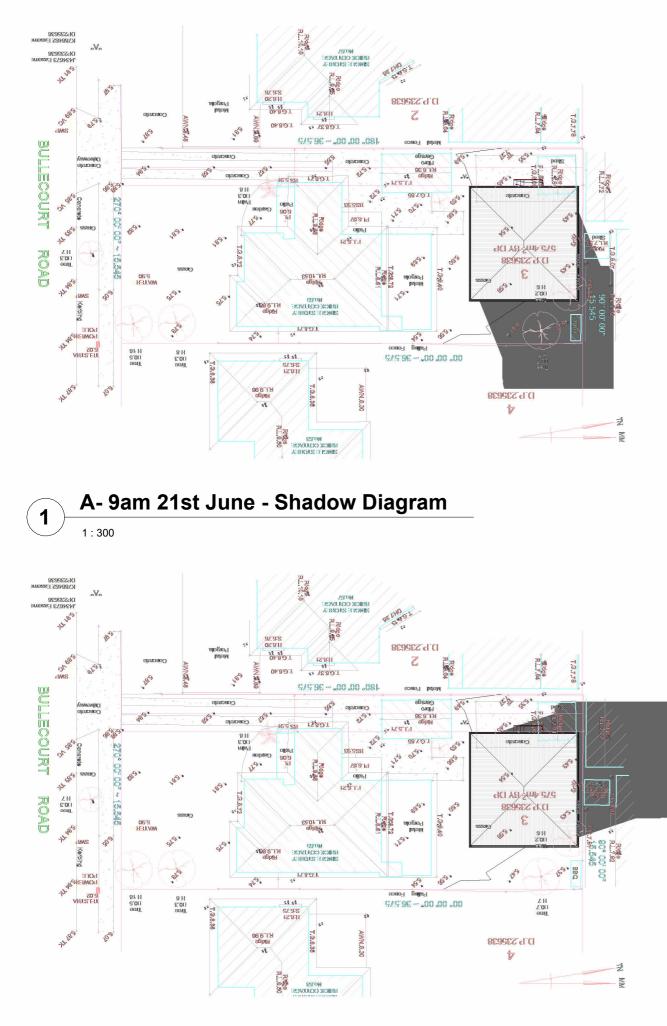
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NOTE: * Architectural documents are to be read in conjunction with relevant structural, fire	CONSULTANTS:	 REV	DATE	DESCRIPTION	INITIAL	DRAWING TITLE:	Site Plan	SITE ADDRESS:65	Bullecou
service, mechanical, hydraulic, electrical, civil and landscaping documents. * Do not scale drawings. Use figured dimensions only. Inform Architect of any conflict between site conditions and documents. Contractor to verify all dimensions on site efore		A	05.12.23	Initial Design	Khaled	DRAWN BY:	K.Kabbout	CLIENT: Mr Sleima	
commencing work. *Any extra work entailed hereafter must be claimed and approval obtained befor proceeding otherwise on extra will allowed for.		B	17.01.24	Issued for DA	Khaled	CHECKED BY:	K.Kabbout	ISSUED FOR: Issu	led for DA
All materials, appliances, fittings and finishes are to be installed in accordance with the manufacturer's recommendations and in compliance with the relevant Codes & Standards * These drawings are not to be used for construction unless drawings are stame endorsed						LOT: 3 SEC:	DP:235638	PROJECT TYPE:	Granny F
¹ Inset trainings are not to be used to consideration times trainings are stample horised by Building Surveyor. ² These documents may only be used for the purposed for which was commissioned and in accordance with the Terms of Engagement.						COUNCIL AREA :	Canterbury-Bankstown	SCALE: 1:200	DATE



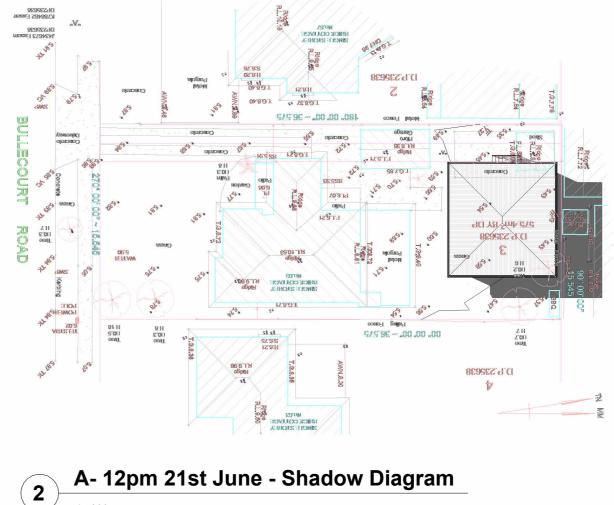



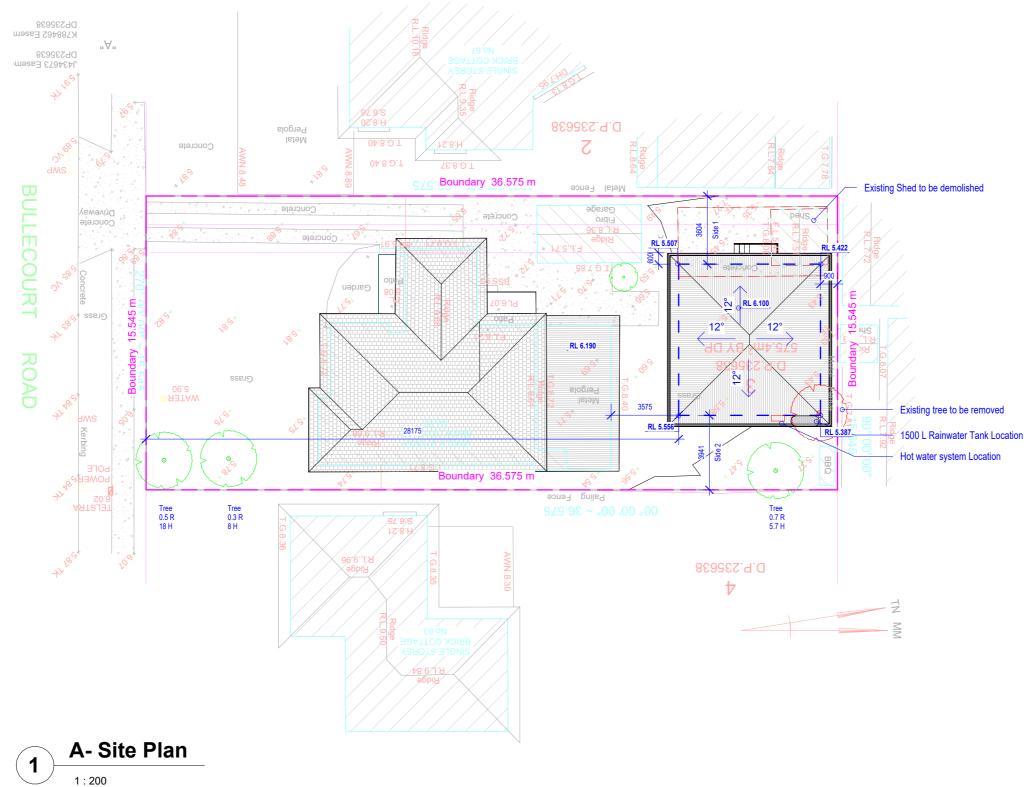

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SITE CADASTRE ©URBANFINITY

Orientation:

Tile Size:

Scale:

Site Address:	65 Bullecourt Ave
	Milperra, 2214 NSW
CRS:	MGA Zone EPSG:28356
Extent:	313578.9, 6242980.6
	313658.9, 6243060.6
Cadastre:	
_atitude:	-33.93679°
Longitude:	150.98340°
Cadastral Title:	3//DP235638
Cadastral Area:	568.57 sam

Month



SITE ANALYSIS 65 Bullecourt Ave, Milperra NSW 2214, Australia **OURBANFINITY** TEMPERATURE & RAINFALL WINDROSE DIAGRAMS Wind Speed km/h (%) Wind Gust km/h (%) 12% (18.3%) Ap Mav 838 Mean: 15.2 km/h, Max: 48.0 km/h Mean: 38.9 km/h, Max: 80.0 km SEASONAL WIND SPEED Spring Autumr Jan Feb Mar Apr May AvaMax[* AvgMin[°C 8.9 SOLAR DIAGRAMS PSYCHROMETRIC DIAGRAM SOLAR IRRADIANCE SOLAR PATH Solar Irradiance 12PM orrected Solar Irradianc 2.7 % 90PM 75° 3PM 9AM 6PN 60. Passive Heating 45° 14 hr 1 Active Heating Jan Feb Mar Apr May Jun Jul Aug Sep Oct Nov Dec

2.5 7.5 12.5 17.5 22.5 Dry-Bulb Temperature [°C]

SITE ANALYSIS PLAN CURBANFINITY

Site Address:	65 Bullecourt Ave
	Milperra, 2214 NSW
CRS:	MGA Zone EPSG:28356
Extent:	313578.9, 6242980.6
	313658.9, 6243060.6
Nearmap Imagery:	
Latitude:	-33.93679°
Longitude:	150.98340°
Resolution:	0.050 m
Capture Date:	2023-11-19
Orientation:	True North
Tile Size:	80m x 80m
Coolor	8.0 m
Scale:	N 1
Scale:	

LOCATION INFORMATION

Nov Dec

Conditionina

37.5

Evaporative Cooling

32.5

LAT: -33.9368 deg, LNG: 150.9834 deg

BOM STATION NUMBERS: 66137, 66161 and 66194

Jun

Jun

Jul Aug Sep

Jul Aug

27.5

. . . . HP

SITE ANALYSIS - EXPLANATORY NOTES

site analysis is a spatial interpolation of the climate conditions at a specific set of coordinates using the three nearest Bureau of Meteorology (BOM) weather stations. The weather conditions are interpolated inverse square distance interpolation. This means that a station 2 km away from the site will be a stronger contributor to the overall mean weather conditions than a station 11 km away from the coordinates.

WINDROSE DIAGRAMS

The upper left windrose diagram is the wind speed for the location determined using an inverse square distance weighting.

nal windrose diagrams are created by taking only data in each sea jurary, Autumn: March-May, Winter: June-July, Spring: August-Nor

SOLAR DIAGRAMS

The left hand plot is the solar irradiance determined for the coordinates. The solar irradiance is determine using the latitude and longitude and is the theoretical maximum average daily irradiance, binned monthly

The corrected solar irradiance is calculated by subtracting the average monthly cloud cover (percentage) from the 3 nearest BOM stations.

The right hand plot is the yearly path of the sun over the site. This is a 3D representation of t movement during the day. The outer circle with the cardinal markings (D*) indicates the horiz surrounding the site. The very center of the plot (90*) known as the zenith, the point directly overhead at the coordinates.

TE: hiteducated documents are to be read in conjunction with relevant structural, fire service, mechanical raulic, electrical, civil and landscaping documents. not scale drawings. Use figured dimensions only. Inform Architect of any conflict between site ditors and documents. Contractor to verify all dimensions on site elfore commencing work. a bit of the dimension of the claimed and approval obtained before proceeding otherwise a minimum of the dimension of the claimed and approval obtained before proceeding otherwise nces, fittings and finishes are to be installed in accordance with the manufacturer's d in compliance with the relevant Codes & Standards not to be used for construction unless drawings are stamp endorsed by Building

cuments may only be used for the purposed for which was commissioned and in a with the Terms of Engagement.





TEMPERATURE & RAINFALL

Temperature and rainfall measurements are taken from BOM data for the year 2000-onwards. This is to avoid the effect that climate change would have on the mean maximum and mean minimum temperature The first diagram is the variation of the max and minimum daily temperatures. We have groupe temperatures monthly and then taken the mean value. The thickness of the segment represen-sigma range of max/min temperatures. The line through the center is the mean maximum/mini

cond diagram is the mean monthly rainfall of the site. As with the temperatures age monthly rainfall across the three weather stations.

The table at the bottom of this section gives the mean maximum/r average monthly rainfall.

PSYCHROMETRIC DIAGRAM

plot is divided into seven areas: active heating, passive heating, humidification, co porative cooling and conditioning.

when energy is used to heat the building (i.e gas heating) while passive heat to store the suns heat within the buildings elements and released who

ne is where water is needed to be added to the air without changing the dry bu







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SITE ADDRESS: 65 Bullecourt Ave, Milperra LOT 3 | SEC: | DP:235638 ISSUED FOR: Issued for DA **PROJECT TYPE:** Granny Flat DATE: Oct 2022 REV: A SHEET NO: 01.1 운 SCALE:





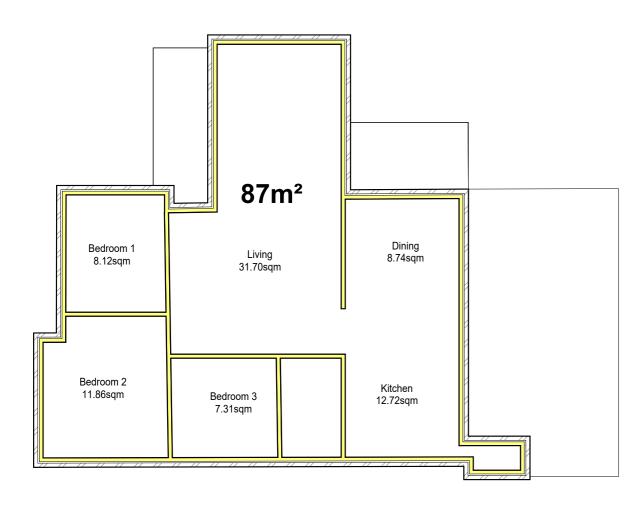


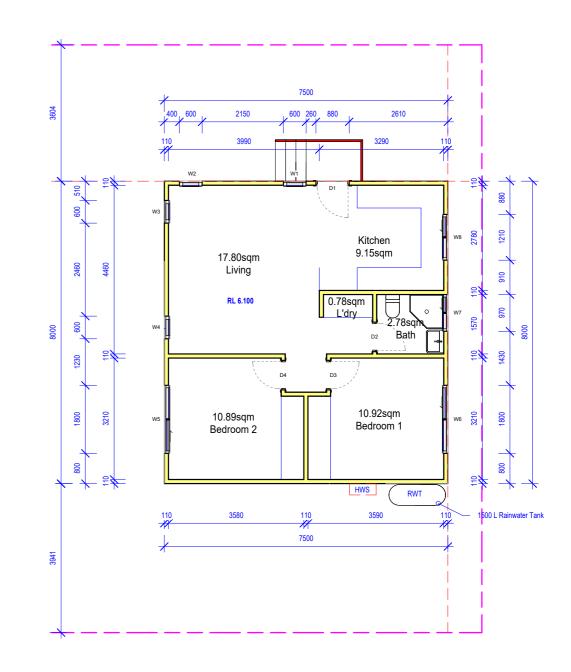





NOTE: * Architectural documents are to be read in conjunction with relevant structural, fire	CONSULTANTS:	 REV	DATE	DESCRIPTION	INITIAL	DRAWING TITLE:	Ground Floor Plan	SITE ADDRESS:65 Bullecou
service, mechanical, hydraulic, electrical, civil and landscaping documents. * Do not scale drawings. Use figured dimensions only. Inform Architect of any conflict between site conditions and documents. Contractor to verify all dimensions on site efore		A 0	5.12.23	Initial Design	Khaled	DRAWN BY:	K.Kabbout	CLIENT: Mr Sleiman
commencing work. *Any extra work entailed hereafter must be claimed and approval obtained befor		B 17	7.01.24	Issued for DA	Khaled	CHECKED BY:	K.Kabbout	ISSUED FOR: Issued for D/
proceeding otherwise no extra will allowed for. *All materials, applicances, fittings and finishes are to be installed in accordance with the manufacturer's recommendations and in compliance with the relevant Codes & Standards.						LOT: 3 SEC:	DP:235638	PROJECT TYPE: Granny F
*These drawings are not to be used for construction unless drawings are stamp endorsed by Building Surveyor. *These documents may only be used for the purposed for which was commissioned and in accordance with the Terms of Engagement.						COUNCIL AREA :	Canterbury-Bankstown	SCALE: 1:100 DAT



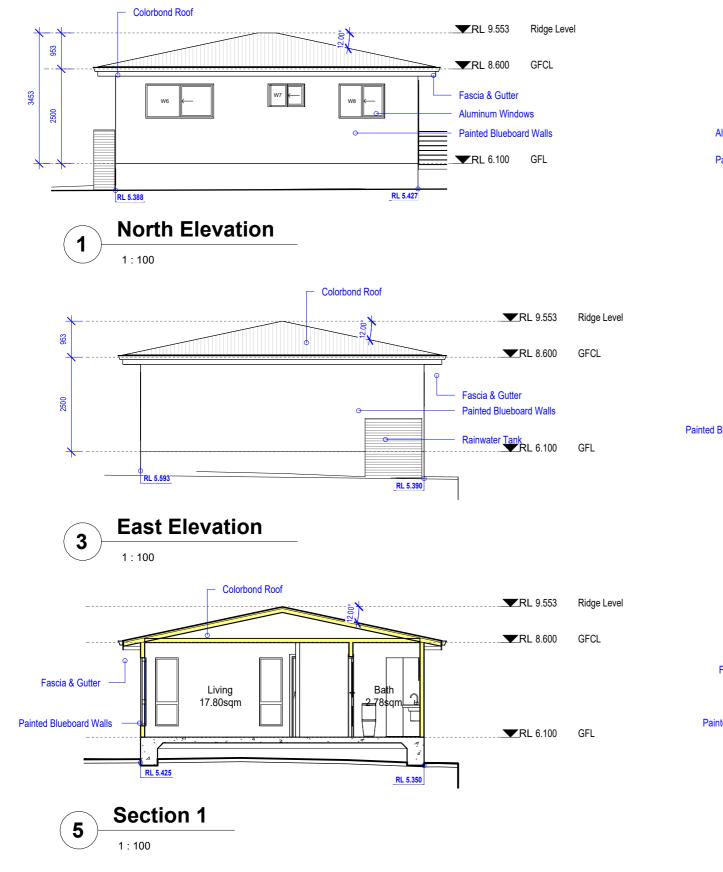


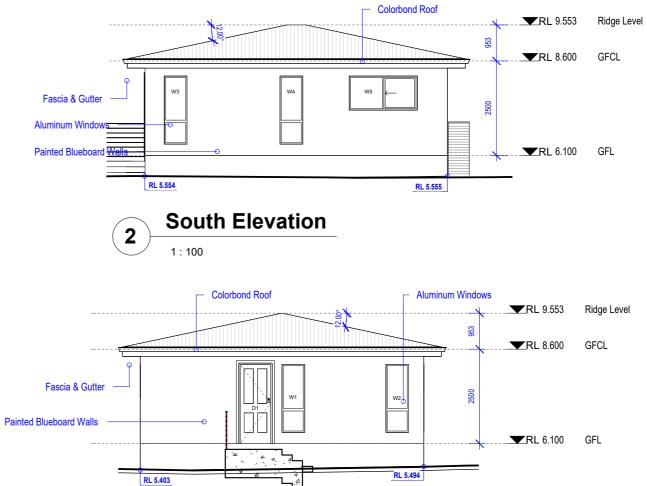


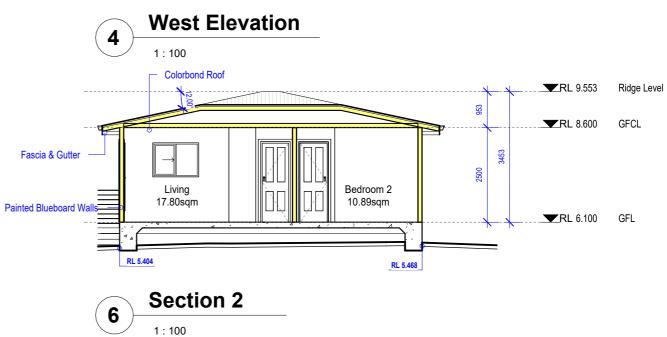

NOTE: * Architectural documents are to be read in conjunction with relevant structural, fire	CONSULTANTS:	REV	DATE	DESCRIPTION	INITIAL	DRAWING TITLE: Elevations & Section	าร	SITE ADDRESS:65 Bullecourt
service, mechanical, hydraulic, electrical, civil and landscaping documents. * Do not scale drawings. Use figured dimensions only. Inform Architect of any conflict between site conditions and documents. Contractor to verify all dimensions on site efore		A	05.12.23	Initial Design	Khaled	DRAWN BY: K.Kabbout		CLIENT: Mr Sleiman
commencing work. *Any extra work entailed hereafter must be claimed and approval obtained befor		В	17.01.24	Issued for DA	Khaled	CHECKED BY: K.Kabbout		ISSUED FOR: Issued for DA
proceeding otherwise no extra will allowed for. "All materials, applicances, fittings and finishes are to be installed in accordance with the manufacturer's recommendations and in compliance with the relevant Codes & Standards "These drawings are not to be used for construction unless drawings are stamp endorsed		-				LOT: 3 SEC: DP:235638		PROJECT TYPE: Granny Fla
 These observations are not be used for construction unless drawings are samp encoded by Building Surveyor. * These documents may only be used for the purposed for which was commissioned and in accordance with the Terms of Engagement. 		-				COUNCIL AREA : Canterbury-Bankst	own	SCALE: 1:100 DATE:



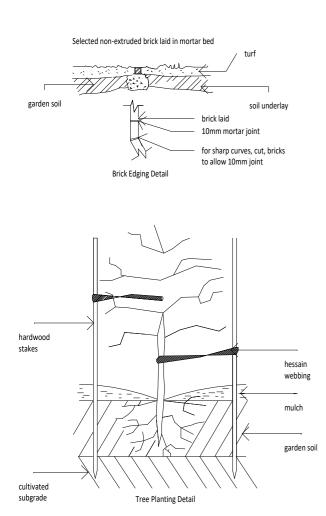

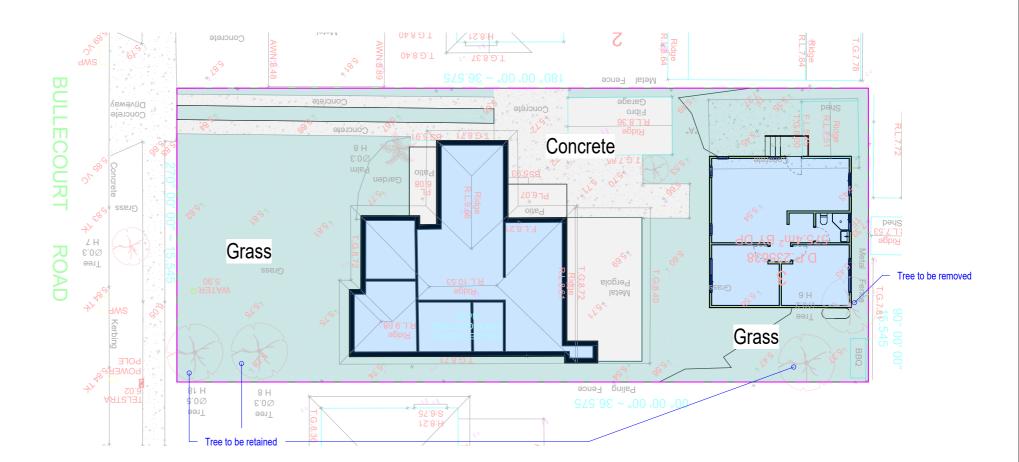



GRASS AREA - 292m² - 50.7%

Landscaping Notes:]								
Turfed Area * All newly turfed areas to be selected weed free pennistum Turf shall be laid neatly butted with staggered joints flush wir running falls to all drainage points. Garden Areas * All garden areas are to be filled with 250mm depth of weed has been treated with spent mushroom compost.	th adjacent surfaces and have even I free top quality garden soil which	Botanic Name	Common Name	Quantity	Staking	Size				
 Proivde a minimum 75mm depth of pine bark flakes or sele All new tress shall be double stalked using underwood stak double tied with hessain webbing. 	•	Trees								
General Notes * Prior to the commencent of any site works, all existing tree enclosed with protective fencing to prevent them being dama										
 * All finished levels are to be verified by the builder on site. * All finished levels are to be verified by the builder on site. * All landscaping work to be in strict accordance to councils/ guidlines. * This drawing is to be read in conjuction with all submitted a * Hydraulics and engineering drawings where applicable. 	privated certifiers code and	<u>Shrubs</u>								
NOTE: * Architectural documents are to be read in conjunction with relevant structural, fire service, mechanical, hydraulic, electrical, civil and landscaping documents. * Do not scale drawings. Use figured dimensions only, Inform Architect of any conflict between site conditions and documents. Contractor to verify all dimensions on site efore commencing work. * Any extra work entailed hereafter must be claimed and approval obtained befor proceeding otherwise no extra will allowed for. * All materials, appliances, filtings and finishes are to be installed in accordance with the manufacturer's recommendations and in compliance with the relevant Codes & Standards by Building Surveyor. * These documents may only be used for the purposed for which was commissioned and in accordance with the Terms of Engagement.	CONSULTANTS:			itial Desig sued for D	n	RIPTIO	N INITIAL Khaled Khaled	DRAWING TITLE: DRAWN BY: CHECKED BY: LOT: 103 SEC: COUNCIL AREA :	K.Kabbout K.Kabbout	SITE ADDRESS:65 Bulled CLIENT: Mr Sleiman ISSUED FOR: Issued for PROJECT TYPE: Grann SCALE: As indicated D









40 Hector St, Chester Hill NSW, 2162 www.cedardesign.com.au info@cedardesign.com.au Phone: 0422 704 479 A.B.N: 87 616 143 661 bdd Reg #: 2125/16



Window	Schedule
VVIIIGOVV	Ochequie

|--|

W1	Living	Awining	1800	600	Aluminum	Clear
W2	Living	Awining	1800	600	Aluminum	Clear
W3	Living	Awining	1800	600	Aluminum	Clear
W4	Living	Awining	1800	600	Aluminum	Clear
W5	Bedroom	Slide	900	1800	Aluminum	Clear
W6	Bedroom	Slide	900	1800	Aluminum	Clear
W7	Bath	Slide	600	970	Aluminum	Obscure
W8	Kitchen	Slide	900	1210	Aluminum	Clear

E
B
R
- c

Door Schedule							
Mark	Room Name	Frame Type	Height	Width	Finish	Frame Material	
		, ,,	0				

D1	Entry	Timber	2100	820	Timber	Timber	
D2	Bath	Timber	2100	720	Timber	Timber	
D3	Bedroom	Timber	2100	720	Timber	Timber	
D4	Bedroom	Timber	2100	720	Timber	Timber	
Grand tatal: 4							

Grand total: 4





LEGEND

EXTERNAL WALLS

WHITE PAINTED FINISH BLUEBOARD WALL OR SIMILAR

ROOF

COLORBOND STEEL ROOF WOODLAND GREY OR SIMILAR


FASCIA & GUTTER

COLORBOND STEEL WHITE OR SIMILAR

ALUMINUM WINDOWS

WHITE POWDERCOATED ALUMINIUM OR SIMILAR

Rectural documents are to be read in conjunction with relevant structural, fire service, mechanical, dic, electrical, civil and landscaping documents. Inform Architect of any conflict between site to scale drawings. Use figured dimensions on the effort of the service, the service of the s

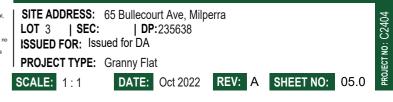






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CONCEPT TO REALITY AUGUNT OF ARTINA Reg #: 2125/16

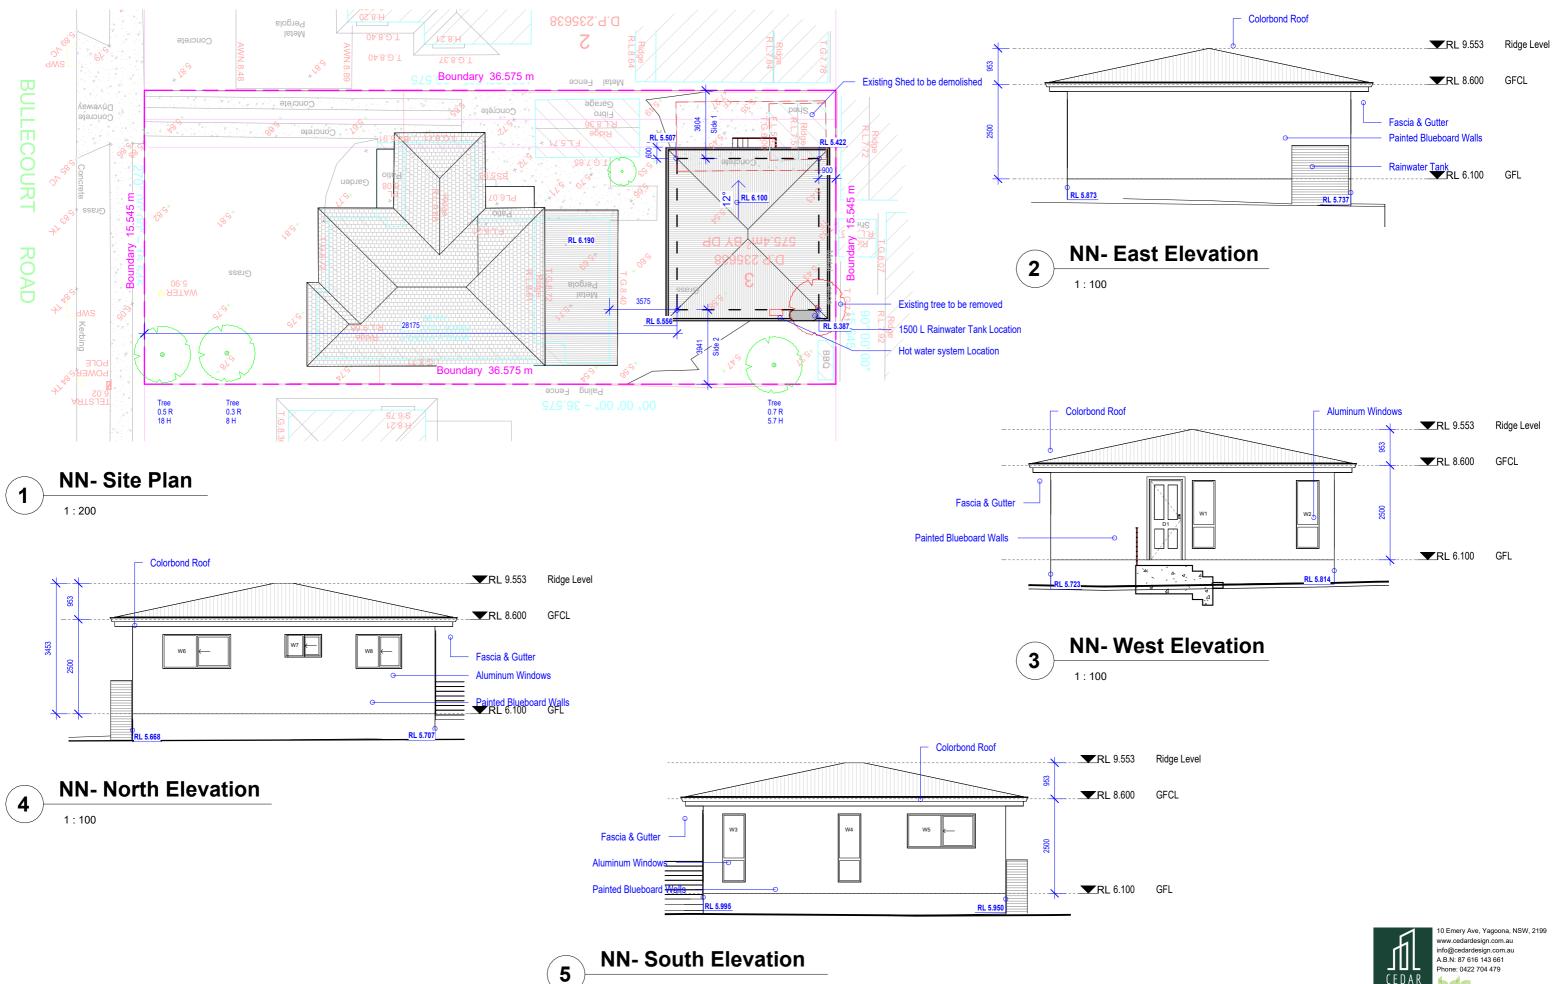

1:100

